# PRELIM/FINAL LAND DEVELOPMENT PLANS

Sheet Number	Sheet Title	1
0.00	COVER	*TO BE RECORDED
1.00	SITE PLAN	*TO BE RECORDED
1.01	EXISTING FEATURES PLAN	
1.02	GRADING AND UTILITIES' PLAN	*TO BE RECORDED
1.03	SITE DETAILS (1)	
1.04	SITE DETAILS (2)	
1.05	PROFILE	
1.06	TURNING TEMPLATE	1
2.00	LANDSCAPING PLAN	
2.01	LIGHTING PLAN	
3.00	EROSION & SEDIMENTATION CONTROL PLAN	*TO BE RECORDED
3.01	E&S DETAILS	
4.00	POST CONSTRUCTION STMWTR MANAGEMENT PLAN	*TO BE RECORDED
4.01	PCSM DETAILS	
5.00	PRE-DEVELOPMENT DRAINAGE SHEDS	
5.01	POST-DEVELOPMENT DRAINAGE SHEDS	1


)F

## MY ANGELO'S PIZZA LD

A COMMERCIAL SITE AT
168 HADDON AVE
WEST BERLIN, NJ 08091
BLOCK 625, LOT 1
BERLIN TOWNSHIP, CAMDEN
COUNTY, NEW JERSEY



70 SULLIVAN WAY MARLTON, NJ 08053

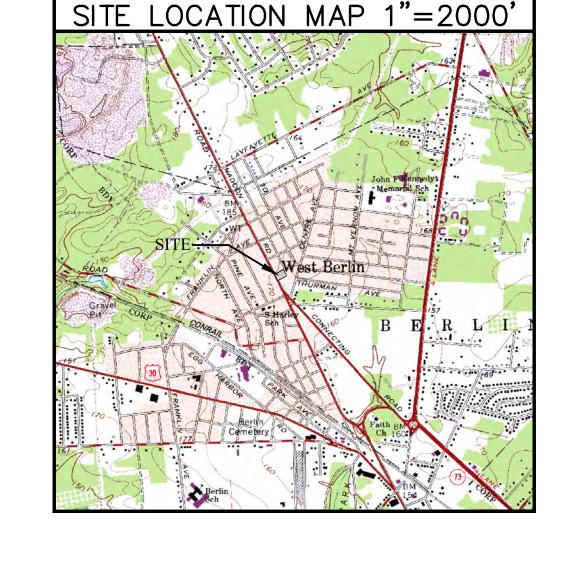

	PLAN REVISIONS					
NO.	REVISION DESCRIPTION	DATE				
1	PER TOWNSHIP ENGINEER CURSORY REVIEW (3-5-21)	04/23/2				
2	PER TOWNSHIP ENGINEER REVIEW (6-9-21)	08/05/2				

PLANS PREPARED BY








Note: These plans are not to be used for construction unless the plan contains a red stamp indicating "ISSUED FOR CONSTRUCTION" by The Crossroads Group, LLC. The Crossroads Group, LLC shall assume no liability for construction performed from plans not containing this stamp.




MY ANGELO'S PIZZA LD
SALVATORE CUSUMANO
BERLIN TOWNSHIP, CAMDEN COUNTY, NEW JERSEY
PROJECT NUMBER: 3824

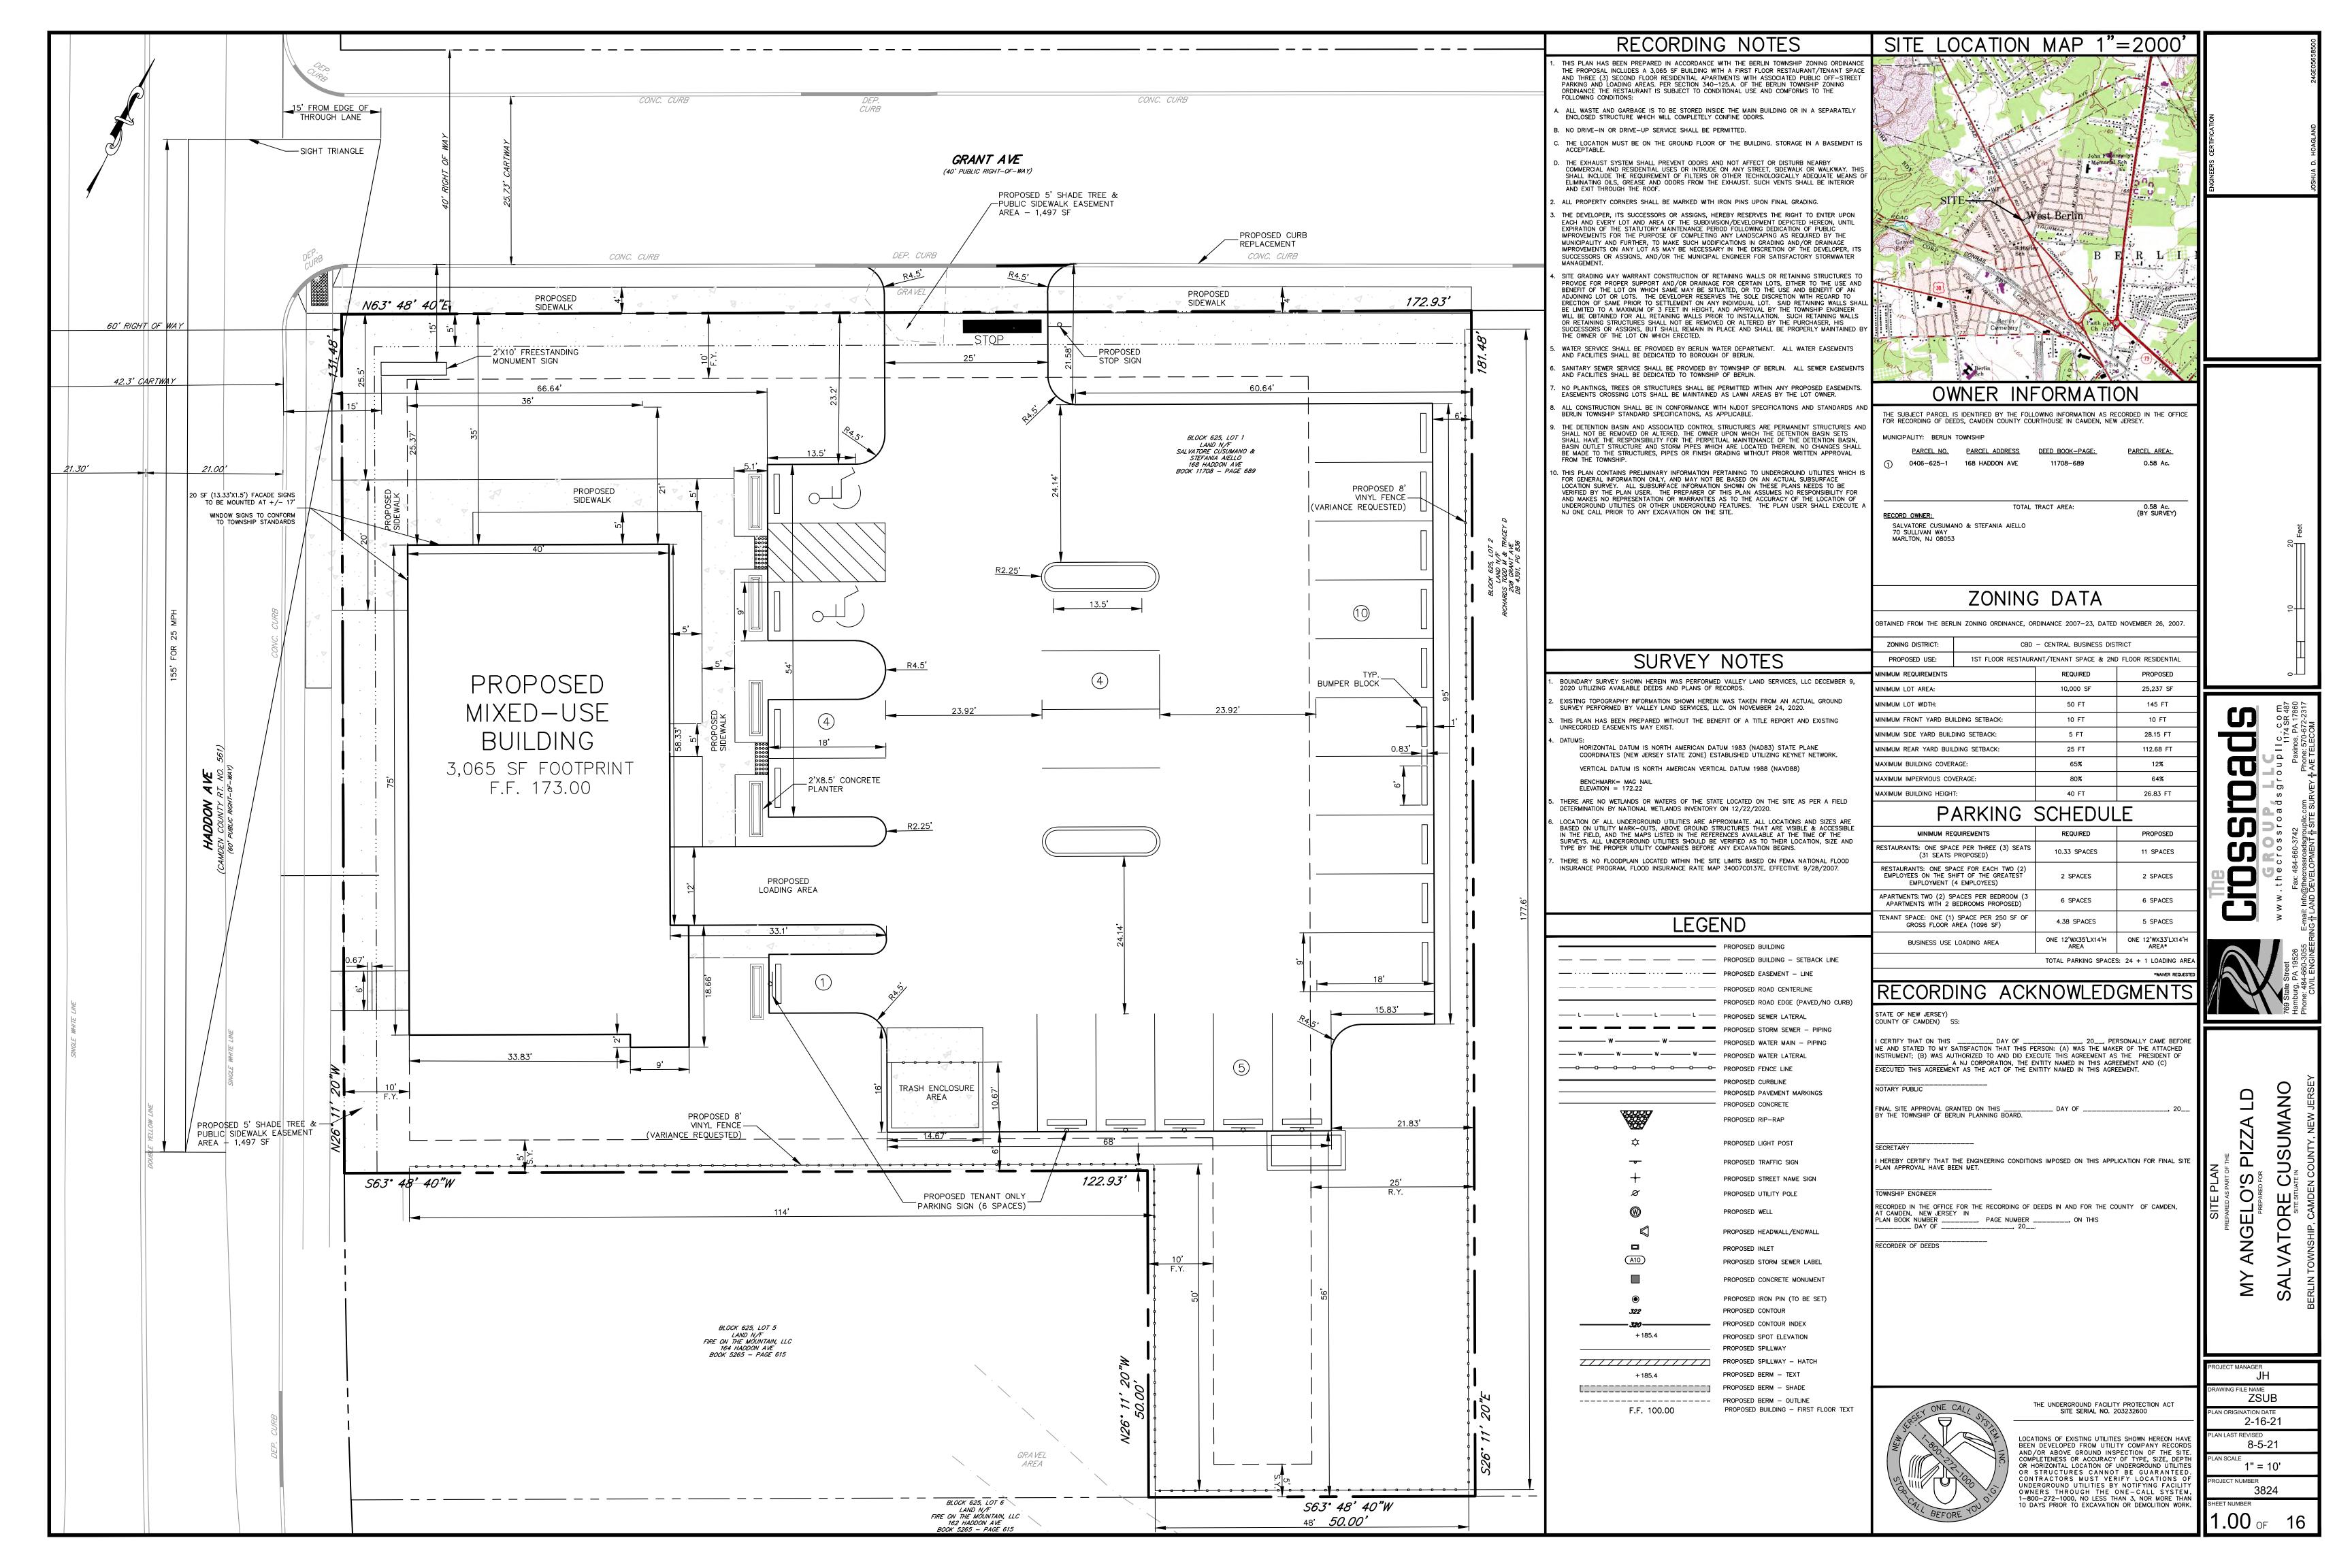

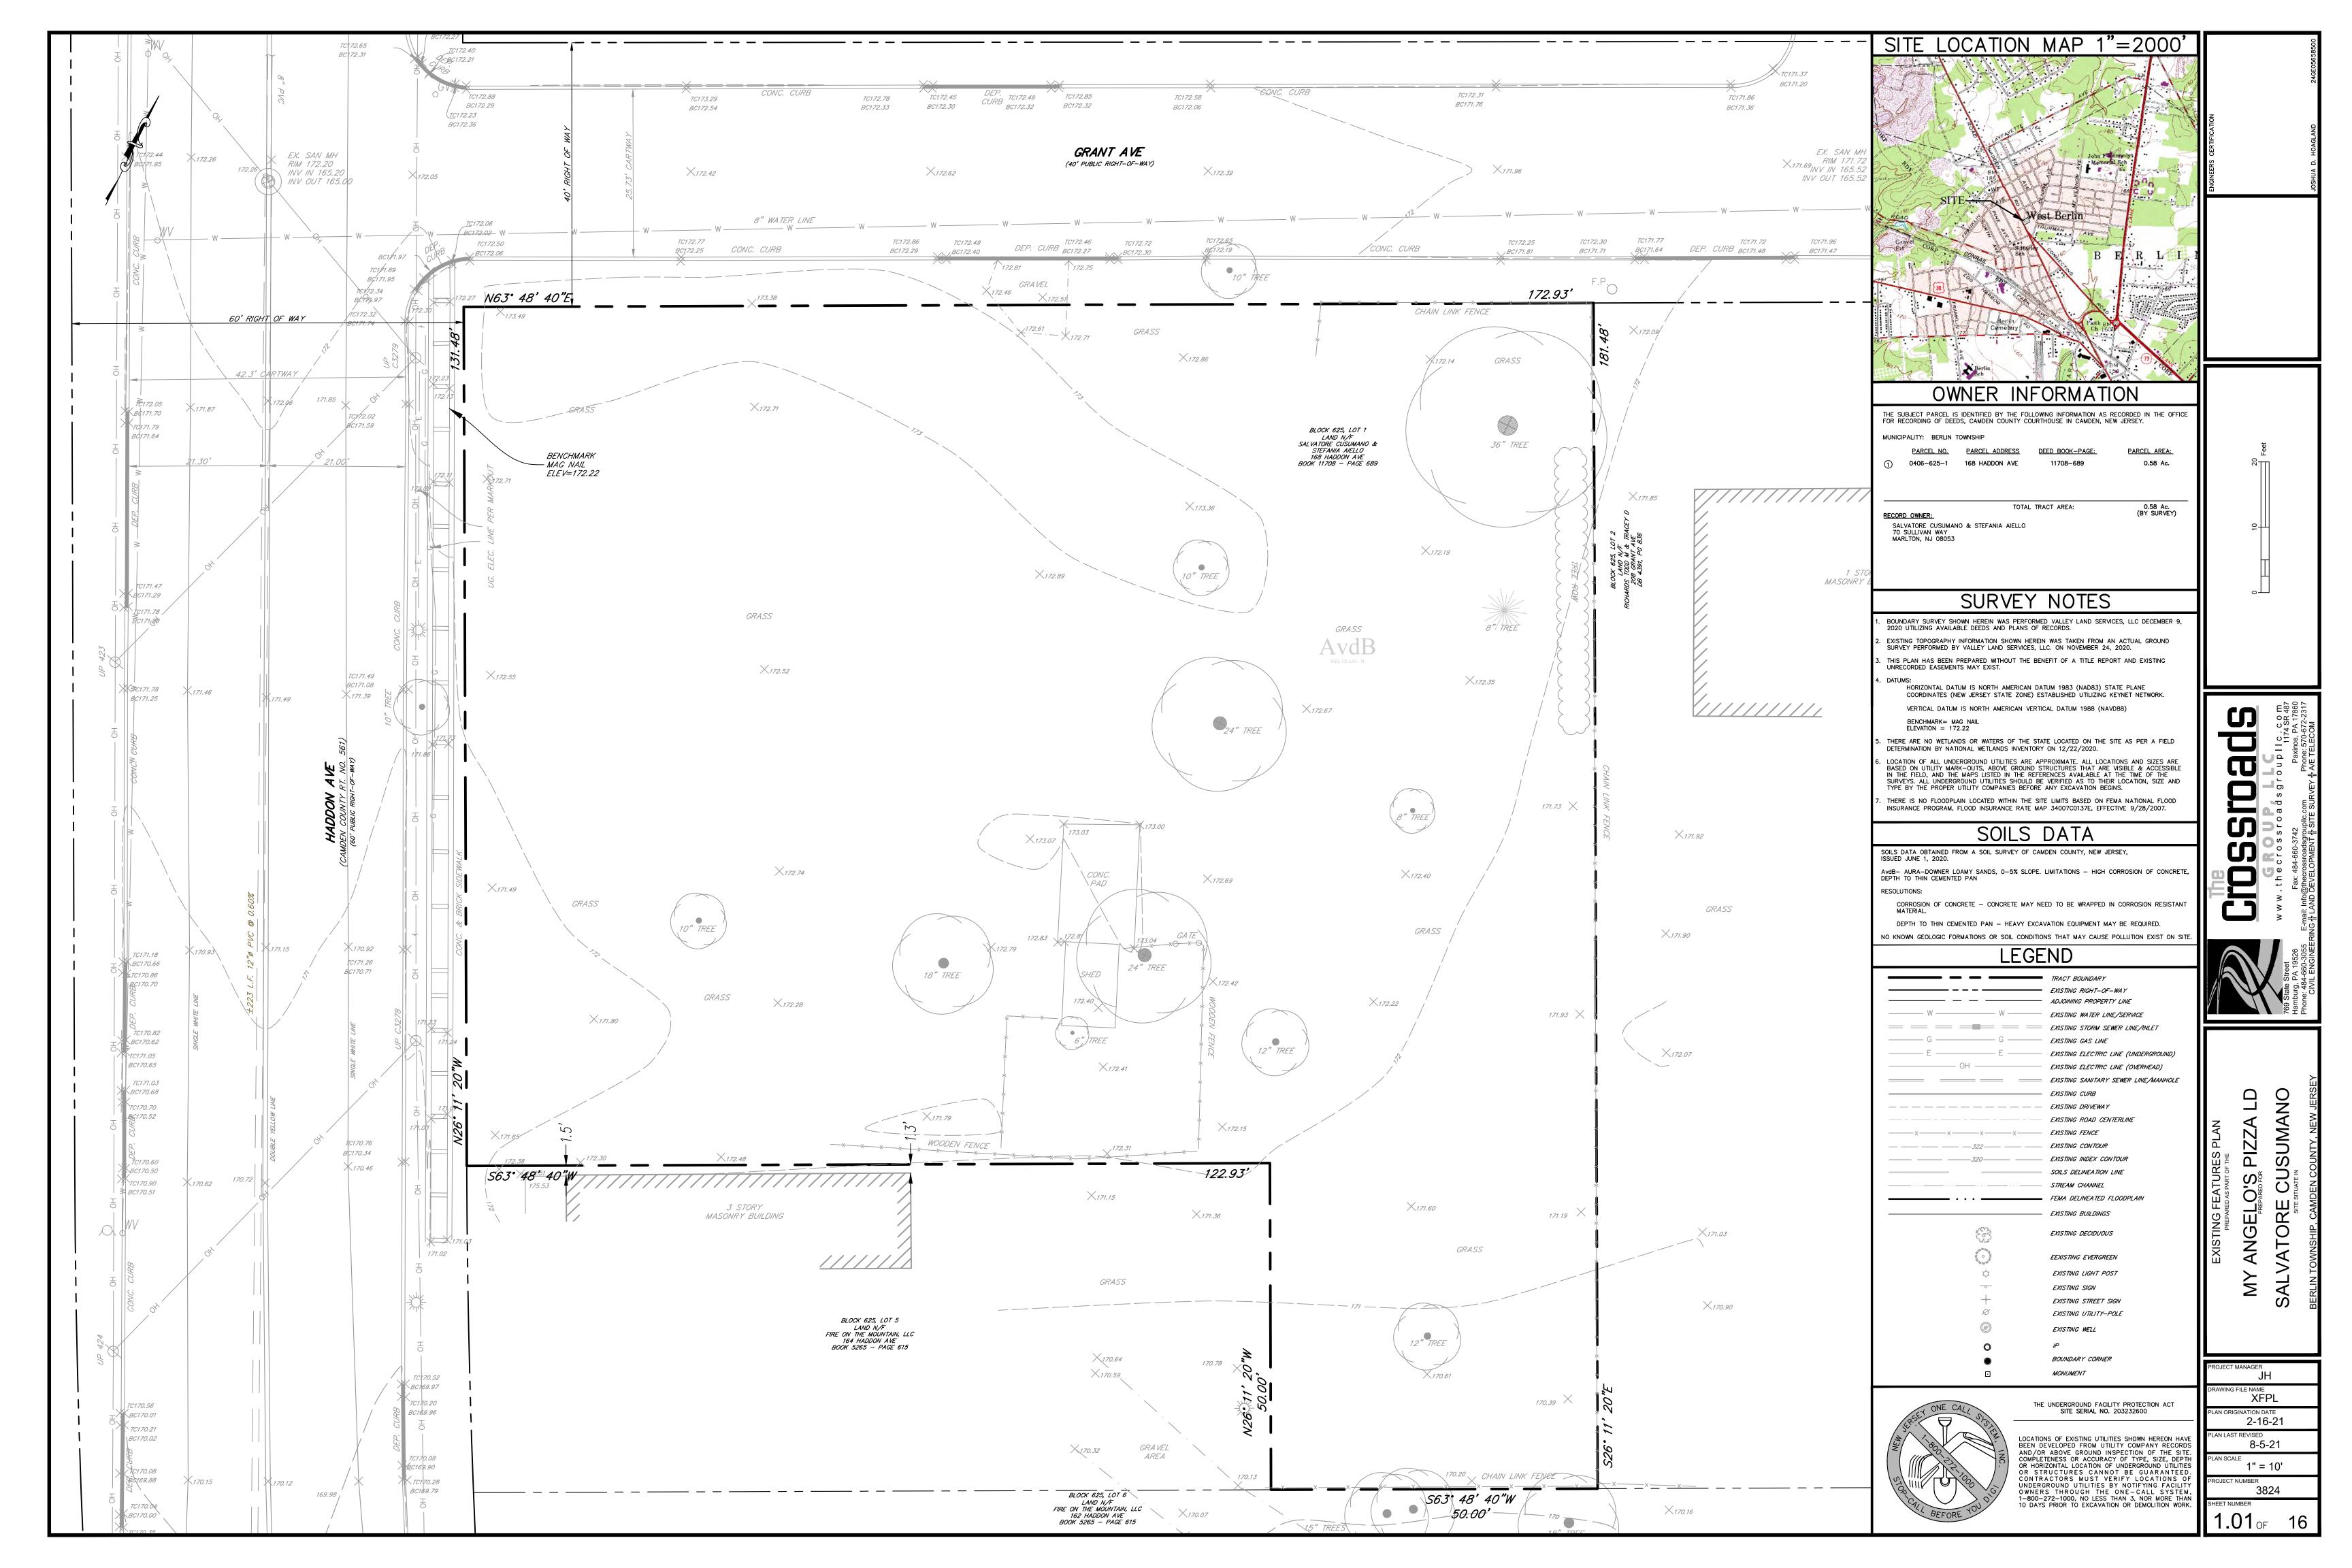

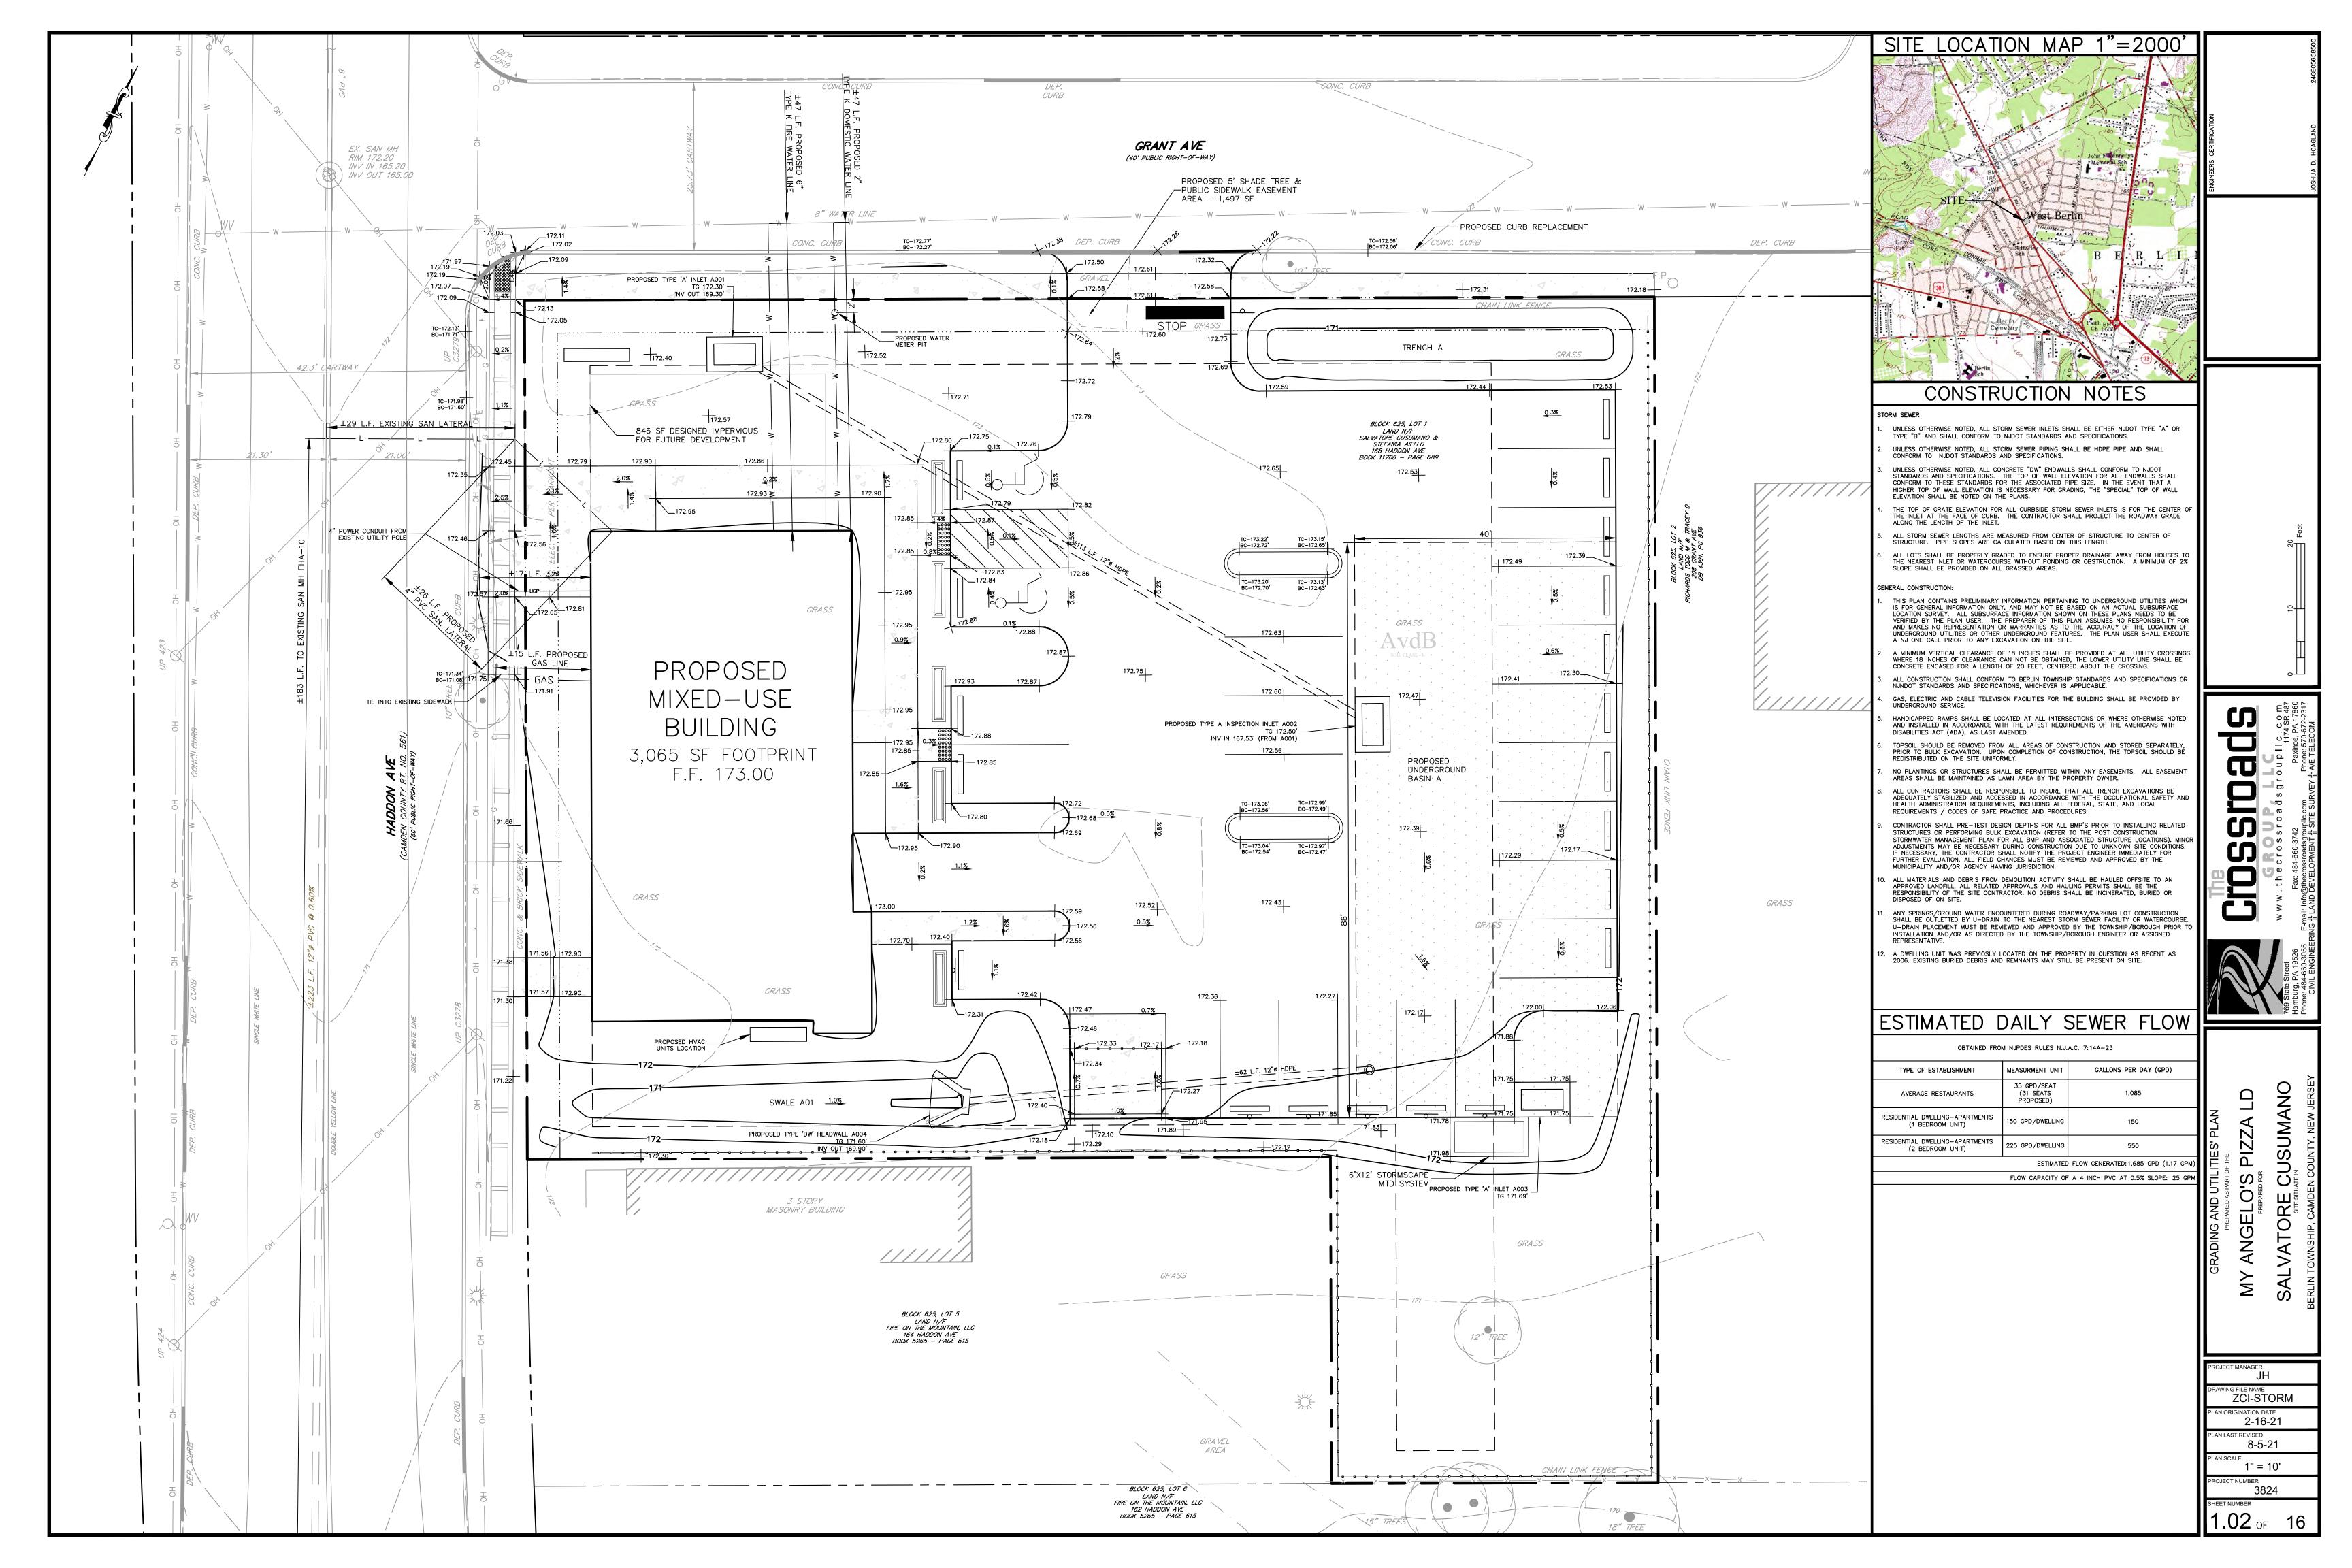

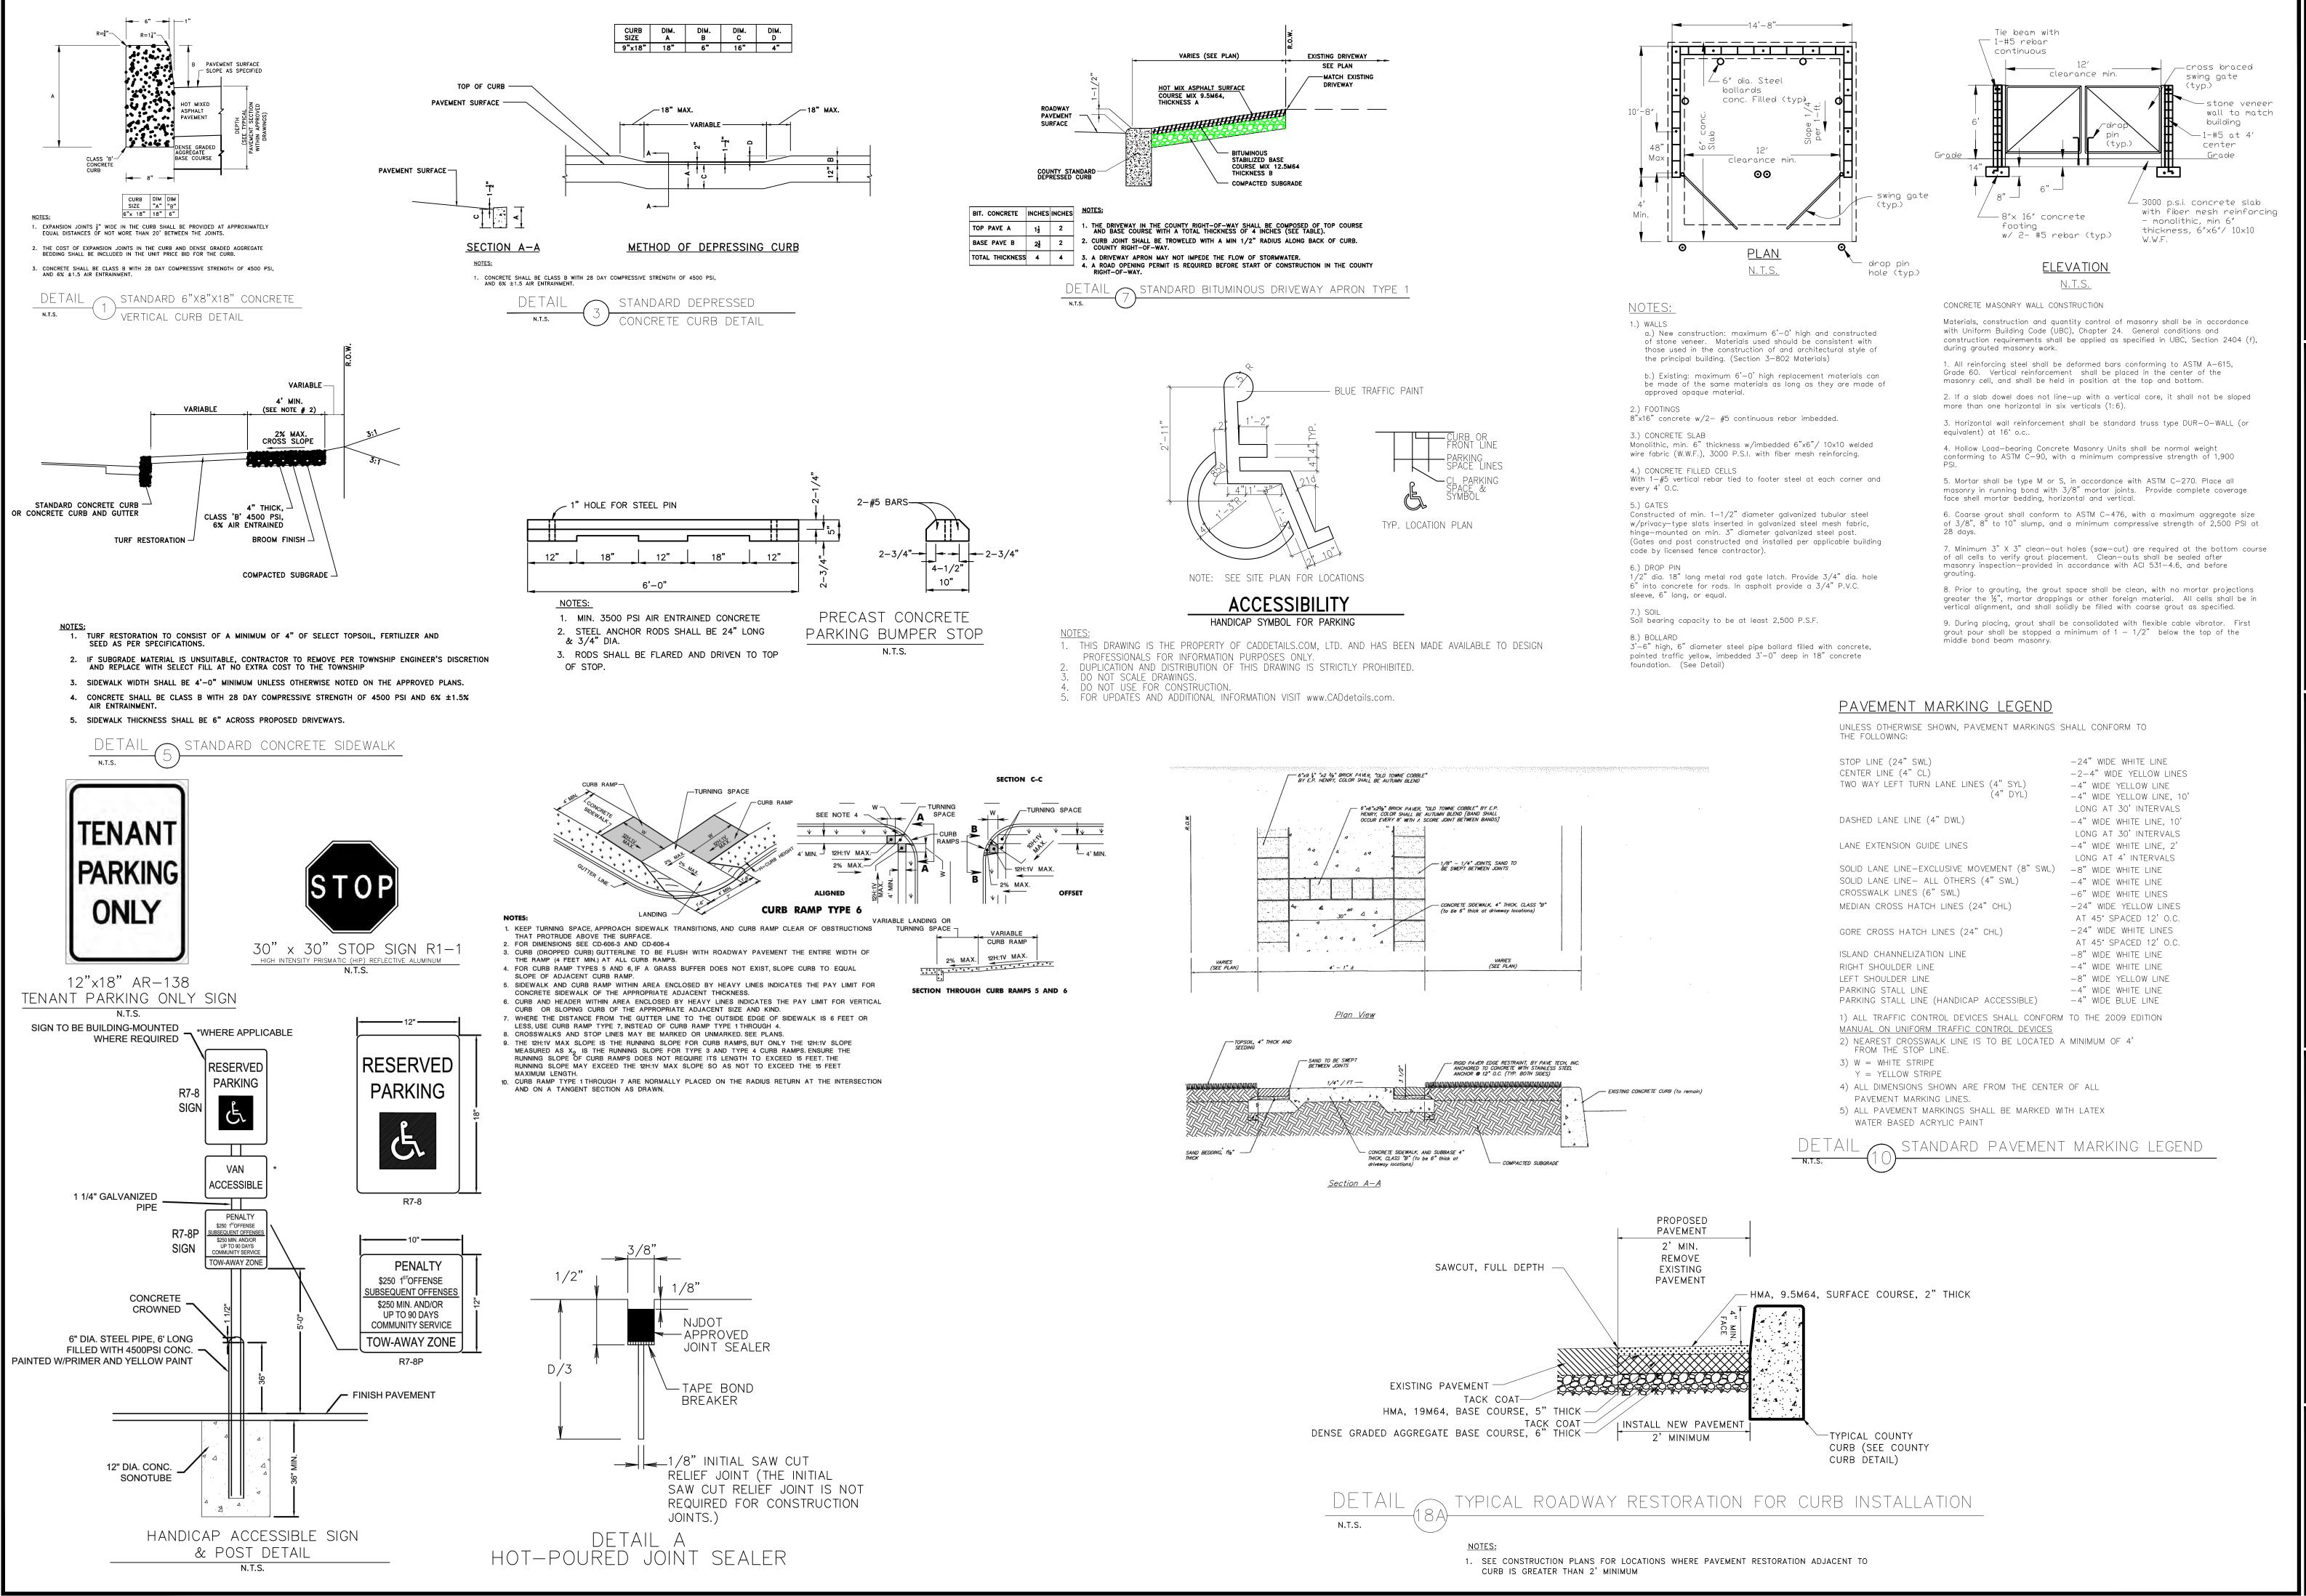

SSTOUP LLC company of the stress of the stre

W W W 769 State Street Hamburg, PA 19526 Phone: 484-660-3055 E-mail: Inforcivit EngineERING # LAND

ANGELO'S PIZZA LD
PREPARED FOR

VATORE CUSUMANO
SITE SITUATE IN

STREVISED

8-5-21

ALE

N.T.S.


N.T.S.

OJECT NUMBER

3824

EET NUMBER

1.03 OF 16

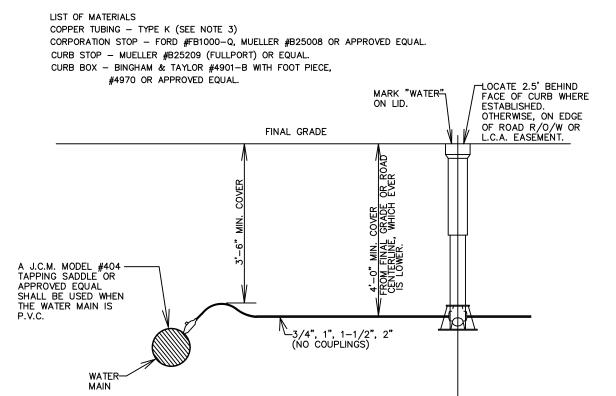


1. AUTHORITY'S SERVICE LINE SHALL HAVE A MIN. 4" BEDDING OF LIMESTONE SCREENINGS AND SHALL BE BACKFILLED TO A MINIMUM 12" OVER PIPE WITH LIMESTONE SCREENINGS.

SERVICE LINE

- 2. AN EXTENSION ROD AND GUIDE RING SHALL BE INSTALLED ON CURB STOPS DEEPER THAN 5 FT. THE TOP OF AN EXTENSION ROD SHALL BE NO DEEPER THAN 5 FT.
- 3. WHERE CLOSED EXCAVATION IS REQUIRED OR DEEMED NECESSARY BY THE AUTHORITY, THE AUTHORITY'S SERVICE LINE SHALL BE INSTALLED WITHIN A SCHEDULE 40 P.V.C. CASING, AND BE POLYETHYLENE PRESSURE TUBING, CLASS 160, CONFORMING TO A.W.W.A. C-901 SPECIFICATIONS, LATEST REVISION.


#### WATER SYSTEM STANDARD DETAIL SMALL SERVICE CONNECTION

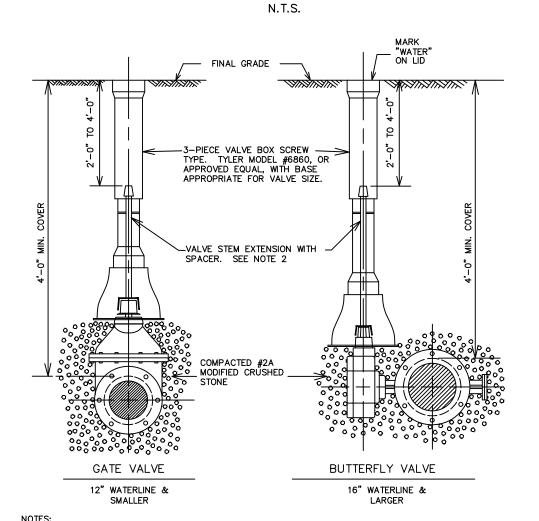

NOTES: 1. VALVES SHALL BE RESTRAINED TO A FITTING USING MEGALUGS, OR AN APPROVED EQUAL. 2. ANY VALVE WHOSE OPERATING NUT IS GREATER THAN 4 FEET DEEP SHALL BE EQUIPPED WITH AN EXTENSION STEM THAT HAS A MINIMUM 1—INCH SQUARE SOLID STEEL SHAFT FITTED OVER THE OPERATING NUT AND HAVE A 2—INCH SQUARE OPERATING NUT ON THE TOP. THE SHAFT SHALL BE CENTERED IN THE BOX WITH A SPACER AND BE FASTENED TO THE OPERATING NUT. THE EXTENSION KIT SHALL BE MANUFACTURED BY THE VALVE

MANUFACTURER OR APPROVED EQUAL.

### WATER SYSTEM STANDARD DETAIL VALVE AND VALVE BOX

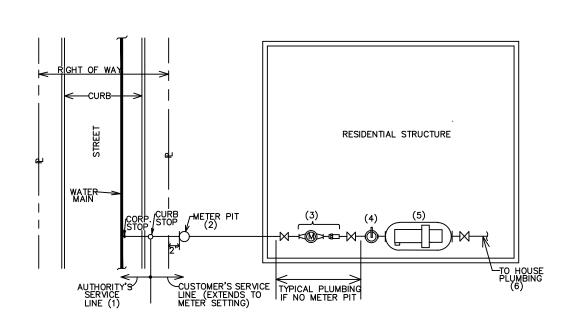

## PARTIAL SITE PLAN

- NOTES:

  1. SEE THE SMALL SERVICE CONNECTION DETAIL FOR THE CONSTRUCTION STANDARDS. A MINIMUM 1" DIAMETER SERVICE LINE IS REQUIRED FOR INSTALLATIONS WITH A METER PIT AND/OR BOOSTER PUMP. THE SIZE OF THE
- CUSTOMER'S SERVICE LINE SHALL BE NO SMALLER THAN THE SIZE OF THE AUTHORITY'S SERVICE LINE.

  2. A METER PIT IS REQUIRED IF THE LENGTH OF THE CUSTOMER'S SERVICE LINE EXCEEDS 100'. SEE THE DOMESTIC SERVICE METER PIT DETAIL.

  3. THE METER AND DUAL CHECK VALVE SHALL BE PURCHASED FROM THE AUTHORITY.

  4. A PRESSURE REDUCING VALVE IS REQUIRED WHEN PRESSURES WILL EXCEED 80 PSI.


  5. A BOOSTER PUMPING SYSTEM MAY BE REQUIRED BY THE AUTHORITY IF THE STATIC PRESSURE IS LESS THAN 45 PSI. MAJOR COMPONENTS OF A BOOSTER PUMPING SYSTEM SHALL INCLUDE A (A) JACUZZI MODEL #5RP2, SHALLOW WELL JET PUMP, (B) FLEXCON INDUSTRIES MODEL #JR44—HS OR MODEL #WR60—02 JET—RITE DIAPHRAGM—TYPE PRESSURE TANK, OR APPROVED EQUAL, INSTALLED IN ACCORDANCE WITH THE TOWNSHIP PLUMBING CODE OR BOCA NATIONAL PLUMBING CODE.

  6. AN ALIXILIARY RELIES VALVE EXPANSION TANK OR DETAILS THE DIAPHRAGH—TYPE PRESSURE TANK, OR APPROVED EQUAL, INSTALLED IN
- CODE.


  6. AN AUXILIARY RELIEF VALVE, EXPANSION TANK OR OTHER MEANS OF PROVIDING FOR THERMAL EXPANSION SHALL BE INSTALLED IN THE INTERNAL PLUMBING SYSTEM TO PREVENT DAMAGE TO THE HOT WATER HEATER AND/OR PLUMBING SYSTEM.

  7. PLEASE CONTACT THE AUTHORITY TO DETERMINE IF A BOOSTER PUMPING SYSTEM IS REQUIRED, OR IF YOU HAVE ANY QUESTIONS ABOUT THE ABOVE REQUIREMENTS. THE AUTHORITY WILL NOT INSTALL A METER IF ANY OF THE ABOVE CRITERIA IS NOT MET.


WATER SYSTEM STANDARD DETAIL TYPICAL RESIDENTIAL SERVICE CONNECTION

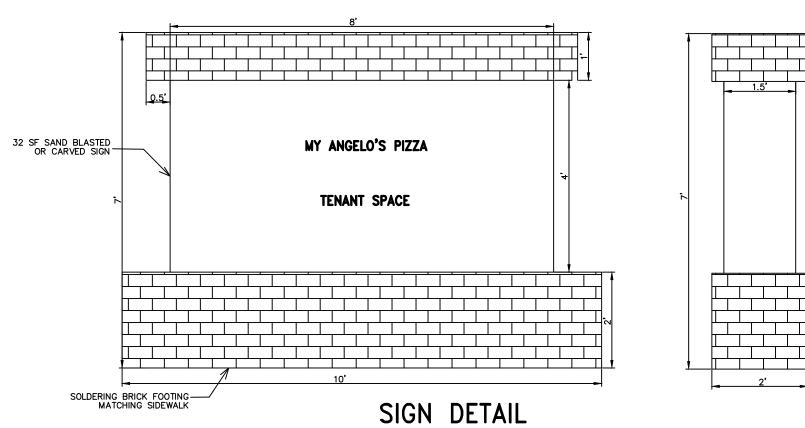


**SPECIFICATION SHEET** 

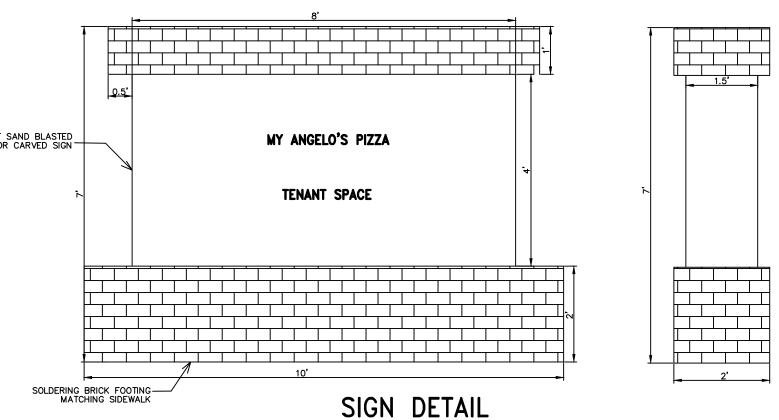


NOTE: SIGN TO COMPLY WITH TOWNSHIP OF BERLIN ZONING CODE

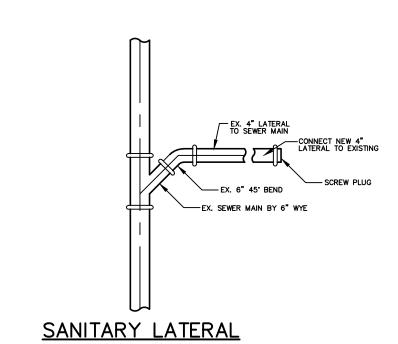

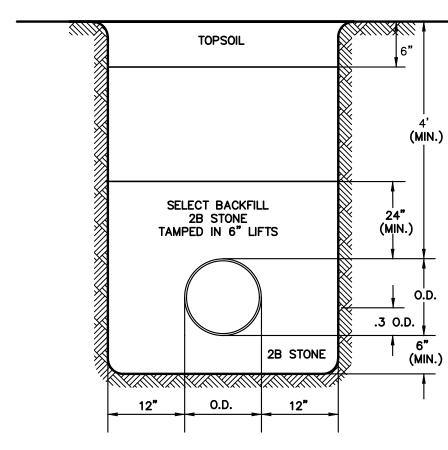


TRENCH RESTORATION DETAIL
IN UNPAVED AREAS

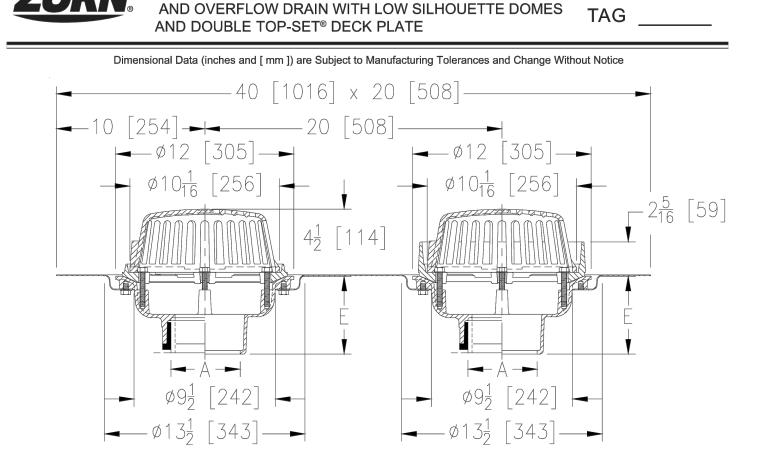

12 [305] DIAMETER COMBINATION MAIN ROOF

A Dina Siza In [mm]	Wt. Area 12" [305mm] Diameter roof drain	ENGINEERING SPECIFICATION: ZURNZ164 12" [305mm] Diameter roof drain and overflow drain, Dura-	
Pipe Size In.[mm]	Lbs. [kg]	Sq. In. [cm²]	Coated cast iron bodies with combination membrane flashing
2, 3, 4, 6 [51, 76, 102, 152]	66 [30]	78 [503]	clamp/gravel guards, double Top-Set® deck plate, and low

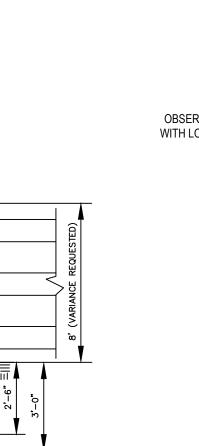

### **VINYL FENCE DETAIL** (TO BE PLACED AS DELINEATED ON THE PLANS) NTS


NOTE: VINYL FENCE MANUFACTURER, STYLE, MATERIAL AND COLOR SHALL BE APPROVED BY THE TOWNSHIP AND/OR THE TOWNSHIP ENGINEER PRIOR TO INSTALLATION.

8' O.C.

\_\_\_ 5"x5" VINYL POST

CONCRETE FOOTING

2"x6" VINYL RAIL (TYP. FOR 3)

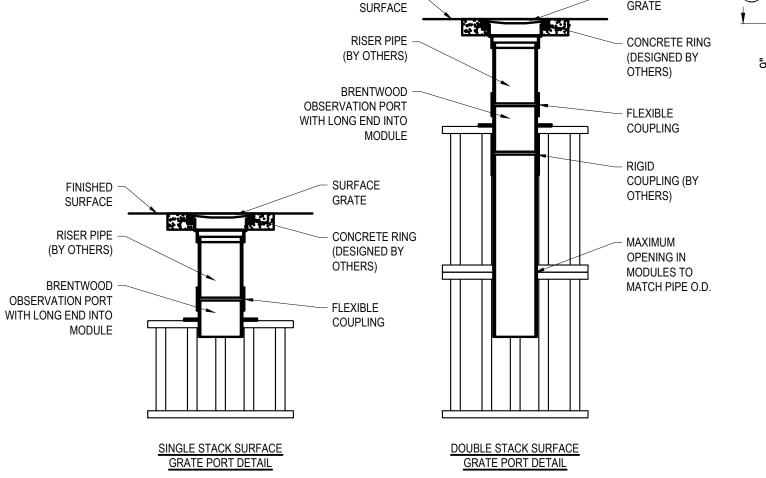


FINISHED -

- 1. INSTALLATION TO BE COMPLETED IN ACCORDANCE WITH MANUFACTURER'S SPECIFICATIONS. 2. DO NOT SCALE DRAWING.
- 3. THIS DRAWING IS INTENDED FOR USE BY ARCHITECTS, ENGINEERS, CONTRACTORS, CONSULTANTS AND DESIGN PROFESSIONALS FOR PLANNING PURPOSES ONLY. THIS DRAWING MAY NOT BE USED FOR CONSTRUCTION.
- 4. ALL INFORMATION CONTAINED HEREIN WAS CURRENT AT THE TIME OF DEVELOPMENT BUT MUST BE REVIEWED AND APPROVED BY THE PRODUCT MANUFACTURER TO BE CONSIDERED ACCURATE. 5. CONTRACTOR'S NOTE: FOR PRODUCT AND COMPANY INFORMATION VISIT www.CADdetails.com/info AND ENTER

STORMTANK MODULE **OBSERVATION PORT DETAIL** 

REFERENCE NUMBER 4907-009.

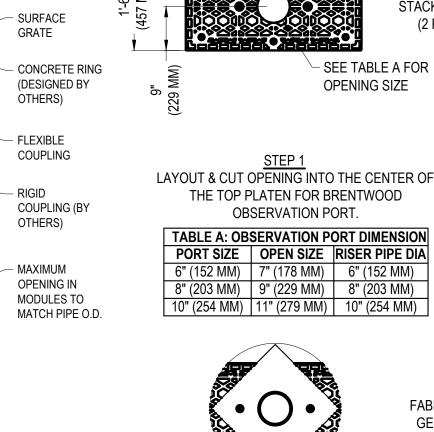

PLAN VIEW - PORT PLATE IN POSITION

MARK & CUT FLANGE PLATE FLUSH WITH

MODULE SIDE "WHEN MODULE IS ON THE

PERIMETER OF THE SYSTEM."

3'-0" (914 MM) —

1'-6"

(457 MM)

NON-WOVEN GEOTEXTILE FABRIC (PROPEX GEOTEX 601 OR **APPROVED** EQUAL)

STEP 5 INSTALL GEOTEXTILE:

WRAP SPECIFIED GEOTEXTILE FABRIC AROUND

ENTIRE INSTALLATION OF STORMTANK MODULES

CUT "X" PATTERN INTO GEOTEXTILE FABRIC AT

OBSERVATION PORT AND PEEL EDGES OUT.

SEAL FABRIC TO OBSERVATION PORT WITH SS BANDING, WATER **RESISTANT TAPE** OR NYLON ZIP-TIE

**OBSERVATION PORT** 

(2 PLACES) — TOP PLATEN

**CIRCULAR RECESSES** 

(2 PLACES)

STEP 2



INSTALL OBSERVATION PORT

STEP 6 SEAL FABRIC TO **OBSERVATION PORT** 

#### 1. INSTALLATION TO BE COMPLETED IN ACCORDANCE WITH MANUFACTURER'S SPECIFICATIONS. 2. DO NOT SCALE DRAWING.

STACKING PIN

- SEE TABLE A FOR

**OPENING SIZE** 

(2 PLACES)

- 3. THIS DRAWING IS INTENDED FOR USE BY ARCHITECTS, ENGINEERS, CONTRACTORS, CONSULTANTS AND DESIGN PROFESSIONALS FOR PLANNING PURPOSES ONLY. THIS DRAWING MAY NOT BE USED FOR CONSTRUCTION. 4. ALL INFORMATION CONTAINED HEREIN WAS CURRENT AT THE TIME OF DEVELOPMENT BUT MUST BE REVIEWED AND
- 5. CONTRACTOR'S NOTE: FOR PRODUCT AND COMPANY INFORMATION VISIT www.CADdetails.com/info AND ENTER REFERENCE NUMBER 4907-010.


APPROVED BY THE PRODUCT MANUFACTURER TO BE CONSIDERED ACCURATE.


ANGEL

> ZDET 2-16-21

8-5-21 N.T.S.

3824

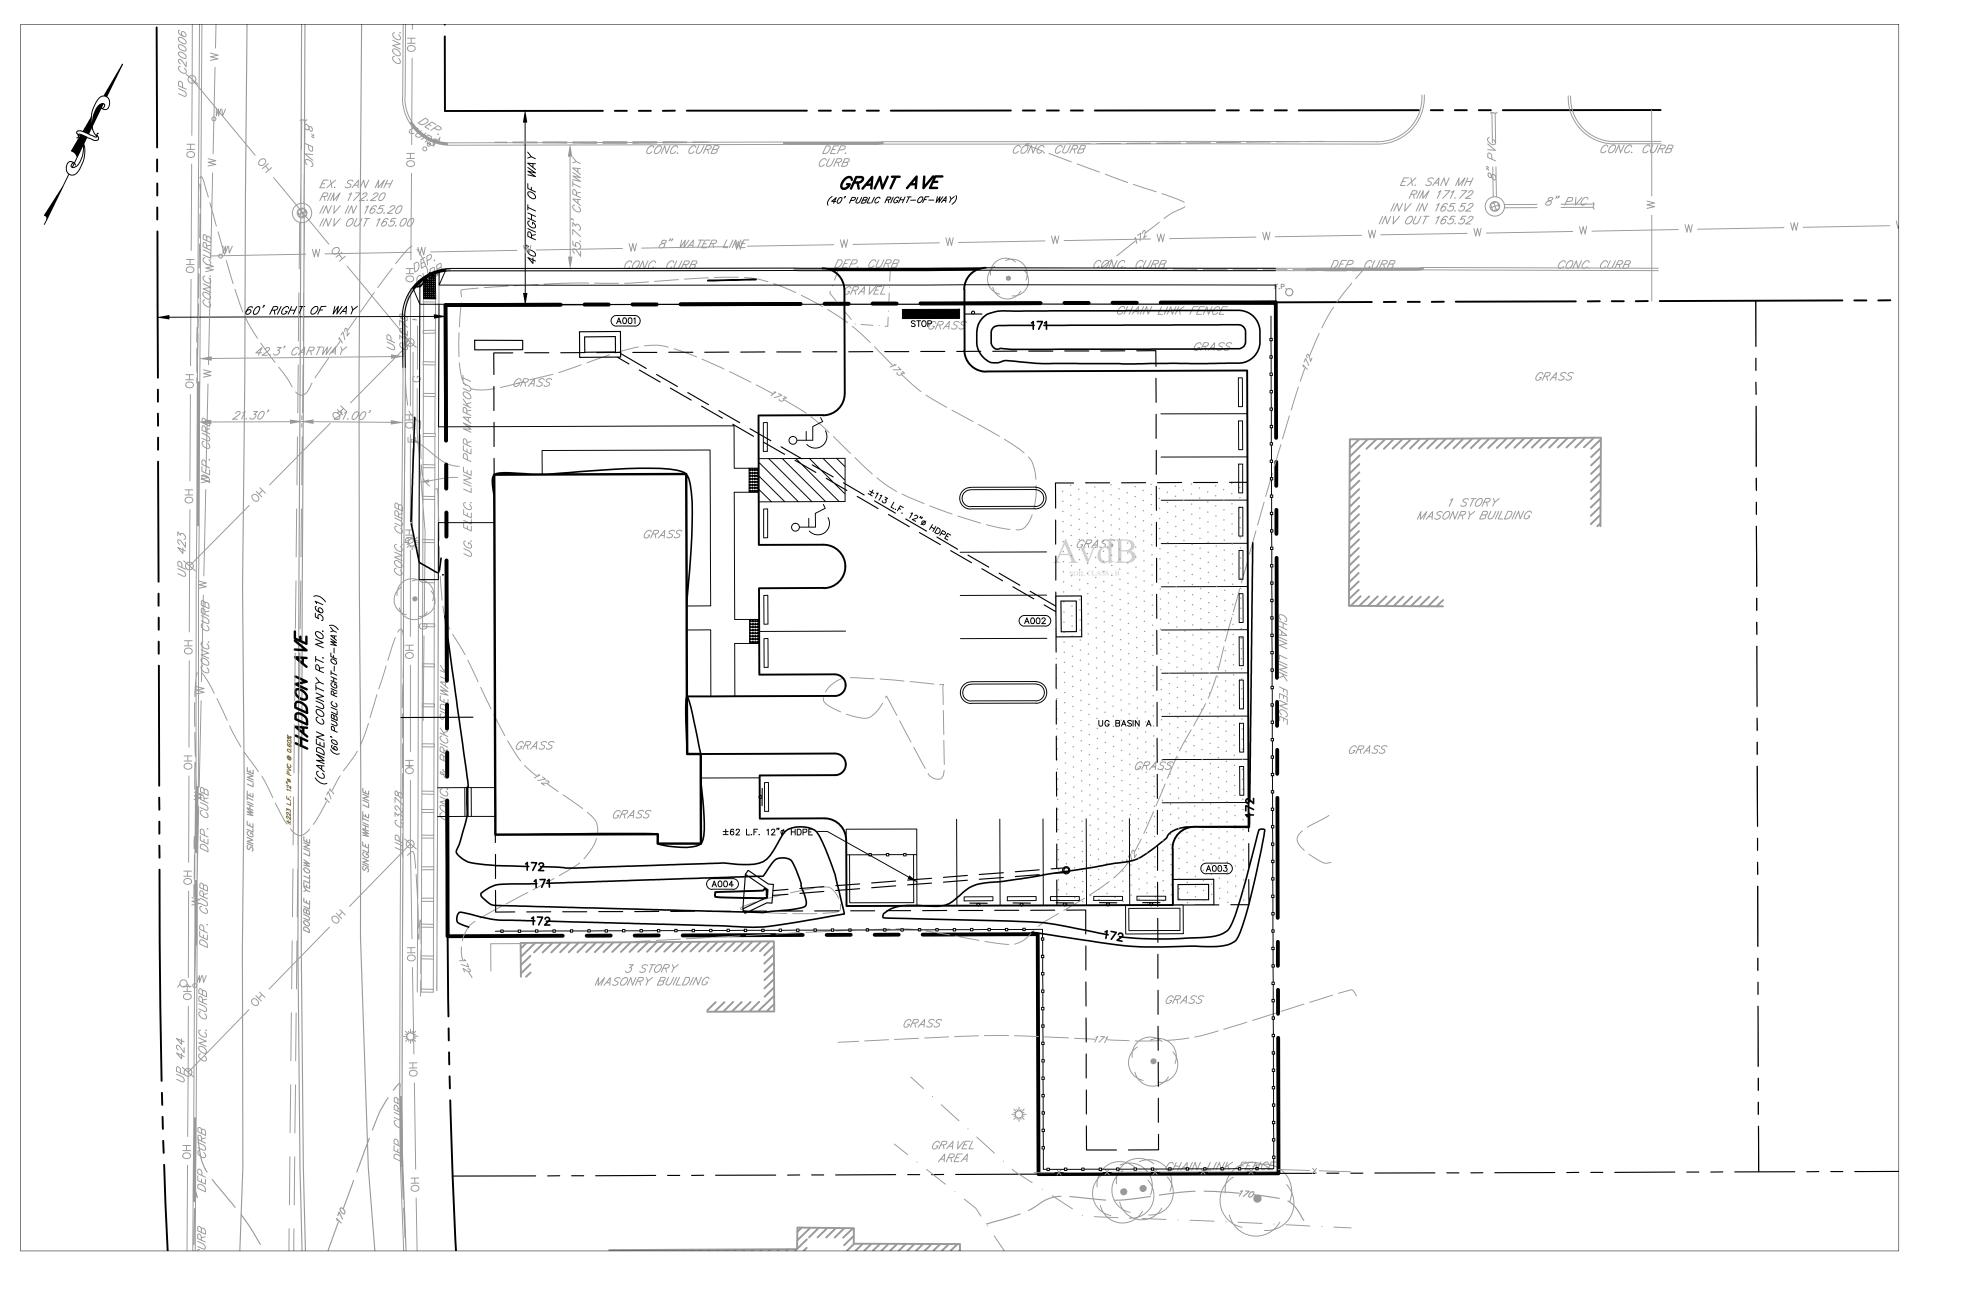

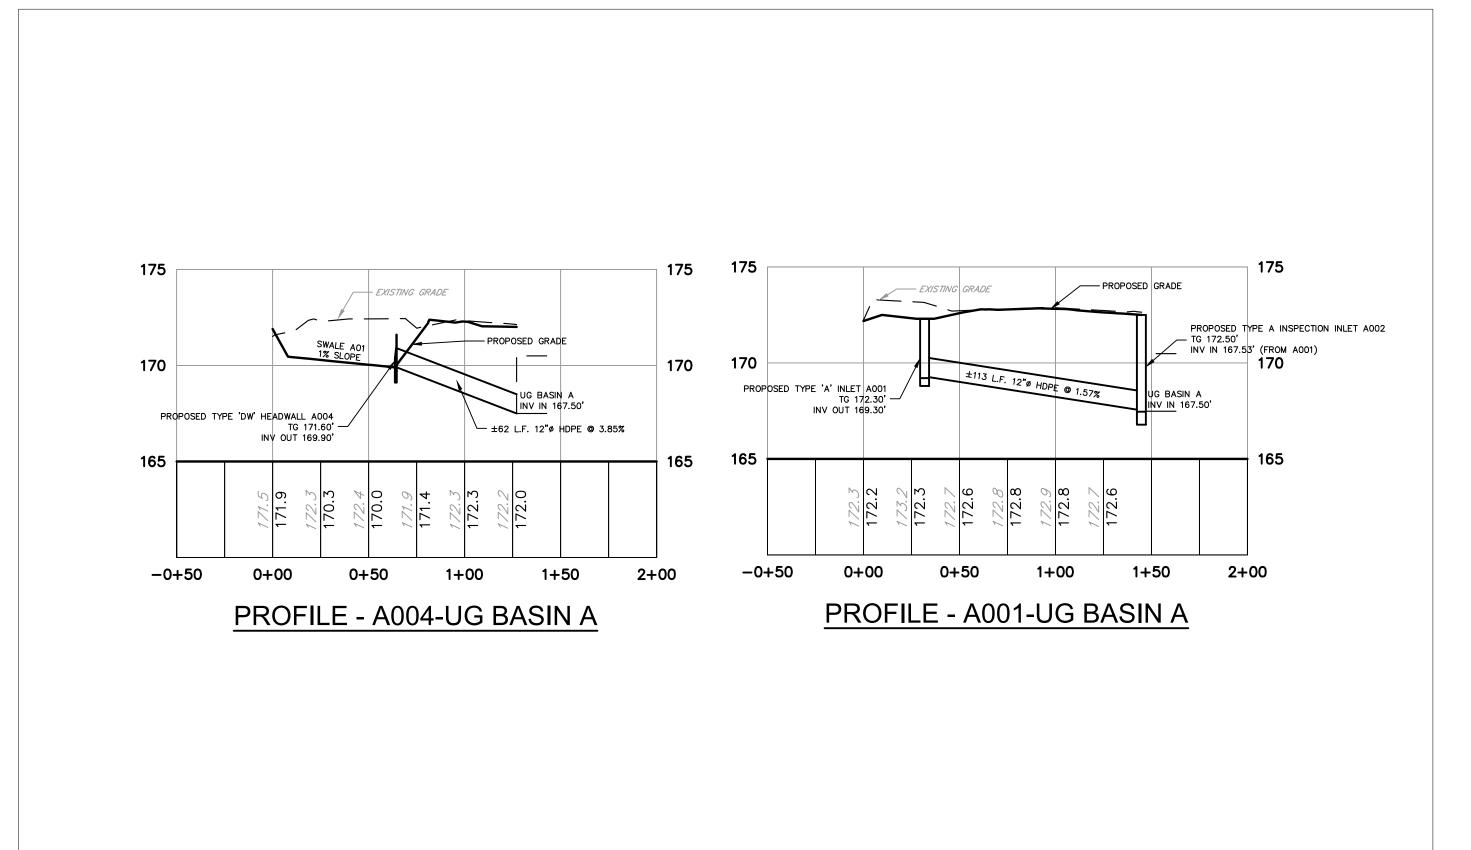

## CONSTRUCTION NOTES

UNLESS OTHERWISE NOTED, ALL STORM SEWER INLETS SHALL BE EITHER NJDOT TYPE "A" OR TYPE "B" AND SHALL CONFORM TO NJDOT STANDARDS AND SPECIFICATIONS.

UNLESS OTHERWISE NOTED, ALL STORM SEWER PIPING SHALL BE HDPE PIPE AND SHALL CONFORM TO NJDOT STANDARDS AND SPECIFICATIONS.

UNLESS OTHERWISE NOTED, ALL CONCRETE "DW" ENDWALLS SHALL CONFORM TO NJDOT STANDARDS AND SPECIFICATIONS. THE TOP OF WALL ELEVATION FOR ALL ENDWALLS SHALL CONFORM TO THESE STANDARDS FOR THE ASSOCIATED PIPE SIZE. IN THE EVENT THAT A HIGHER TOP OF WALL ELEVATION IS NECESSARY FOR GRADING, THE "SPECIAL" TOP OF WALL ELEVATION SHALL BE NOTED ON THE PLANS.

THE TOP OF GRATE ELEVATION FOR ALL CURBSIDE STORM SEWER INLETS IS FOR THE CENTER OF THE INLET AT THE FACE OF CURB. THE CONTRACTOR SHALL PROJECT THE ROADWAY GRADE ALONG THE LENGTH OF THE INLET.

ALL STORM SEWER LENGTHS ARE MEASURED FROM CENTER OF STRUCTURE TO CENTER OF STRUCTURE. PIPE SLOPES ARE CALCULATED BASED ON THIS LENGTH. ALL LOTS SHALL BE PROPERLY GRADED TO ENSURE PROPER DRAINAGE AWAY FROM HOUSES TO THE NEAREST INLET OR WATERCOURSE WITHOUT PONDING OR OBSTRUCTION. A MINIMUM OF 2% SLOPE SHALL BE PROVIDED ON ALL GRASSED AREAS.

#### GENERAL CONSTRUCTION:

THIS PLAN CONTAINS PRELIMINARY INFORMATION PERTAINING TO UNDERGROUND UTILITIES WHICH IS FOR GENERAL INFORMATION ONLY, AND MAY NOT BE BASED ON AN ACTUAL SUBSURFACE LOCATION SURVEY. ALL SUBSURFACE INFORMATION SHOWN ON THESE PLANS NEEDS TO BE VERIFIED BY THE PLAN USER. THE PREPARER OF THIS PLAN ASSUMES NO RESPONSIBILITY FOR AND MAKES NO REPRESENTATION OR WARRANTIES AS TO THE ACCURACY OF THE LOCATION OF UNDERGROUND UTILITIES OR OTHER UNDERGROUND FEATURES. THE PLAN USER SHALL EXECUTE A NJ ONE CALL PRIOR TO ANY EXCAVATION ON THE SITE.

A MINIMUM VERTICAL CLEARANCE OF 18 INCHES SHALL BE PROVIDED AT ALL UTILITY CROSSINGS. WHERE 18 INCHES OF CLEARANCE CAN NOT BE OBTAINED, THE LOWER UTILITY LINE SHALL BE CONCRETE ENCASED FOR A LENGTH OF 20 FEET, CENTERED ABOUT THE CROSSING. ALL CONSTRUCTION SHALL CONFORM TO BERLIN TOWNSHIP STANDARDS AND SPECIFICATIONS OR NJNDOT STANDARDS AND SPECIFICATIONS, WHICHEVER IS APPLICABLE.

GAS, ELECTRIC AND CABLE TELEVISION FACILITIES FOR THE BUILDING SHALL BE PROVIDED BY UNDERGROUND SERVICE.

HANDICAPPED RAMPS SHALL BE LOCATED AT ALL INTERSECTIONS OR WHERE OTHERWISE NOTED AND INSTALLED IN ACCORDANCE WITH THE LATEST REQUIREMENTS OF THE AMERICANS WITH DISABILITIES ACT (ADA), AS LAST AMENDED.


TOPSOIL SHOULD BE REMOVED FROM ALL AREAS OF CONSTRUCTION AND STORED SEPARATELY, PRIOR TO BULK EXCAVATION. UPON COMPLETION OF CONSTRUCTION, THE TOPSOIL SHOULD BE REDISTRIBUTED ON THE SITE UNIFORMLY. NO PLANTINGS OR STRUCTURES SHALL BE PERMITTED WITHIN ANY EASEMENTS. ALL EASEMENT AREAS SHALL BE MAINTAINED AS LAWN AREA BY THE PROPERTY OWNER. ALL CONTRACTORS SHALL BE RESPONSIBLE TO INSURE THAT ALL TRENCH EXCAVATIONS BE ADEQUATELY STABILIZED AND ACCESSED IN ACCORDANCE WITH THE OCCUPATIONAL SAFETY AND HEALTH ADMINISTRATION REQUIREMENTS, INCLUDING ALL FEDERAL, STATE, AND LOCAL REQUIREMENTS / CODES OF SAFE PRACTICE AND PROCEDURES.

CONTRACTOR SHALL PRE-TEST DESIGN DEPTHS FOR ALL BMP'S PRIOR TO INSTALLING RELATED STRUCTURES OR PERFORMING BULK EXCAVATION (REFER TO THE POST CONSTRUCTION STORMWATER MANAGEMENT PLAN FOR ALL BMP AND ASSOCIATED STRUCTURE LOCATIONS). MINOR ADJUSTMENTS MAY BE NECESSARY DURING CONSTRUCTION DUE TO UNKNOWN SITE CONDITIONS. IF NECESSARY, THE CONTRACTOR SHALL NOTIFY THE PROJECT ENGINEER IMMEDIATELY FOR FURTHER EVALUATION. ALL FIELD CHANGES MUST BE REVIEWED AND APPROVED BY THE MUNICIPALITY AND/OR AGENCY HAVING JURISDICTION.

. ALL MATERIALS AND DEBRIS FROM DEMOLITION ACTIVITY SHALL BE HAULED OFFSITE TO AN APPROVED LANDFILL. ALL RELATED APPROVALS AND HAULING PERMITS SHALL BE THE RESPONSIBILITY OF THE SITE CONTRACTOR. NO DEBRIS SHALL BE INCINERATED, BURIED OR DISPLAYED OF ON SITE

ANY SPRINGS/GROUND WATER ENCOUNTERED DURING ROADWAY/PARKING LOT CONSTRUCTION SHALL BE OUTLETTED BY U-DRAIN TO THE NEAREST STORM SEWER FACILITY OR WATERCOURSE. U-DRAIN PLACEMENT MUST BE REVIEWED AND APPROVED BY THE TOWNSHIP/BOROUGH PRIOR TO INSTALLATION AND/OR AS DIRECTED BY THE TOWNSHIP/BOROUGH ENGINEER OR ASSIGNED REPRESENTATIVE.

. A DWELLING UNIT WAS PREVIOSLY LOCATED ON THE PROPERTY IN QUESTION AS RECENT AS 2006. EXISTING BURIED DEBRIS AND REMNANTS MAY STILL BE PRESENT ON SITE.

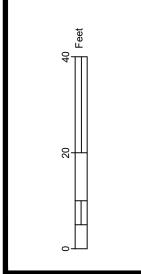



: CUSUMANO SALVATORE

ZPRO 2-16-21 8-5-21 1"=20' 3824

1.05<sub>OF</sub> 16

 $\succeq$ 

